PROPOSED TINY HOME

FOR NUTANA COLLEGIATE



DRAWING LIST

A0.1 GENERAL INFO	RMATION
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TRAILER FRAMING F2.0

F2.1 FLOOR FRAMING

F2.2 LOFT/ROOF FRAMING

A2.1 FLOOR PLAN

LOFT PLAN A2.2

A3.1 **EXTERIOR ELEVATIONS**

SECTION A4.1

SECTION

A4.3 SECTION

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GENERAL NOTES:

- 1. ALL CONSTRUCTION TO COMPLY WITH NATIONAL BUILDING CODE REGULATIONS, RULES, AND BY-LAWS SET BY THE AUTHORITY HAVING JURISDICTION.
- 2. PROVIDE AND MAINTAIN CONTINUOUS AIR/VAPOUR BARRIER SYSTEM, CAULK AROUND OPENINGS AND GAPS WITH SEALANT TO ACHIEVE A CONTINUOS
- 3. VERIFY ALL CONDITIONS AND DIMENSIONS ON SITE PRIOR TO FABRICATION, PROMPTLY NOTIFY THE DESIGNER OF ANY ERRORS OR OMISSIONS.
- 4. DIMENSIONS ARE TAKEN TO OUTSIDE EDGE OF SHEATHING ON EXTERIOR WALLS AND FOUNDATION, AND TO CENTRE OF INTERIOR PARTITION.
- 5. THE GENERAL CONTRACTOR IS TO ARRANGE AND COORDINATE ALL INCOMING AND OUTGOING ELECTRICAL AND MECHANICAL SERVICES FOR THIS PROJECT.
- 6. THE GENERAL CONTRACTOR IS TO COORDINATE ALL ACTIVITIES AS REQUIRED TO ENSURE EFFICIENT. CORRECT AND ORDERLY INSTALLATION OF EACH PART OF THE PROJECT AND TO AVOID CONFLICT IN THE TRADE WORK AND SCHEDULE.
- 7.SHOP DRAWINGS DETAILING ENGINEERED FLOOR. BEAM/LINTELS. AND TRUSSES ARE REQUIRED TO BE SUBMITTED ON SITE FOR THE FRAMING INSPECTION.
- 8. ALL DOORS AND WINDOWS REFERENCED ON PLANS AND SCHEDULES ARE SHOWN NOMINAL SIZE. CONFIRM AND VERIFY ALL ROUGH OPENING SIZE REQUIREMENTS WITH THE SELECTED PRODUCT MANUFACTURER AND SITE CONDITIONS PRIOR TO FABRICATION.
- 9. PROVIDE AND INSTALL SOLID BLOCKING AND BACKING WITHIN THE WALLS FOR ALL WASHROOM ACCESSORIES, HANDRAILS, GUARDS, LADDERS, MECHANICAL AND ELECTRICAL FIXTURES AND EQUIPMENT, ETC. AS REQUIRED FOR PROPER ANCHORING.
- 10. ALL CONSTRUCTION TO COMPLY WITH INDUSTRY TRADE STANDARDS, AS WELL AS MANUFACTURERS' RECOMMENDATIONS. TO THE EXTENT THAT THOSE INSTRUCTIONS AND RECOMMENDATIONS ARE EXPLICIT OR STRINGENT AS THE REQUIREMENTS CONTAINED IN THESE CONTRACT DOCUMENTS.
- 11. CONFIRM ALL ROUGH OPENING SIZES AND CONNECTION REQUIREMENTS FOR MECHANICAL, ELECTRICAL, AND OWNER SUPPLIED EQUIPMENT. ADJUST ROUGH OPENING SIZES TO SUIT.
- 12. INSTALL OWNER SUPPLIED EQUIPMENT AS DIRECTED. CENTERED. LEVEL AND TRUE.
- 13. PROVIDE ALL WARRANTIES, BONDS, AND MANUFACTURER'S OPERATING INSTRUCTION AND SERVICE MANUALS AS WELL AS PARTS LISTS AT THE COMPLETION OF THE PROJECT.

CONSTRUCTION NOTES:

- 1. WALL AND ROOF SHEATHING MUST BE EDGE NAILED AT 6'oc AND FIELD NAILED AT 12' oc.
- 2. ALL LUMBER MUST BE SPF #2 OF BETTER AND INSTALLED ACCORDING TO NBC 2010
- 3. THE SIZE OF ALL LINTELS MUST CONFORM TO TABLE A-12 TO A-15 OF THE NBC 2010. SPANS MORE THAN 9'-0" MUST HAVE DOUBLE JACK STUDS ON EITHER SIDE OF THE HEADER. SECURE JACK STUDS TO FULL LENGTH STUDS WITH DOUBLE NAILING 16" oc.
- 4. EACH BEDROOM MUST HAVE AT LEAST ONE WINDOW WHICH OPENS AND HAVE AN UNOBSTRUCTED AREA OF .35SQM. NO DIMENSIONS OF THIS OPENING CAN BE LESS THAN 15". AWNING WINDOWS DO NOT MEET EGRESS REQUIREMENTS.
- 5. ELECTRICALLY OPERATED SMOKE ALARMS MUST BE PROVIDED ON ALL FLOORS. ALARMS MUST BE INTERCONNECTED AND HARDWIRED, AND IN EACH BEDROOM.
- 6. ALL FLOOR, WALL, AND ROOF FRAMING AS PER NBC 9.23.

WALL & PARTITION NOTES:

- 1. ALL INTERIOR WALLS EXTEND TO U/S OF STRUCTURE UNLESS NOTED OTHERWISE.
- 2. FOR STUD SPACING, LINTEL SIZES, JOIST SPACING & OTHER RELATED INFORMATION, REFER TO STRUCTURAL DRAWINGS.

ROOF ASSEMBLIES:

1. PROVIDE PROPER METAL FLASHING AT ALL REQUIRED LOCATIONS.

LEGEND



DENOTES CONSTRUCTION TYPE (SEE CONSTRUCTION TYPES A101)



DENOTES DOOR TYPE (SEE DOOR SCHEDULE A801)



XXX DENOTES WINDOW TYPE (SEE WINDOW SCHEDULE A901)



DENOTES KEYNOTE (SEE KEYNOTES ON EACH PAGE)



REFERS TO DETAIL NUMBER

REFERS TO DRAWING NUMBER

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SEAL

PROJECT

NUTANA COLLEGIATE TINY HOUSE


ALAN SUKUT

PROJECT NO.: 1719 DRAWN BY: CMB DATE: SEPTEMBER 25, 2018 SCALE: AS SHOWN/11x17 LAYOUT

MODEL FILE: 1875-Nutana Collegiate-CD01.pl

SHEET TITLE

GENERAL INFORMATION

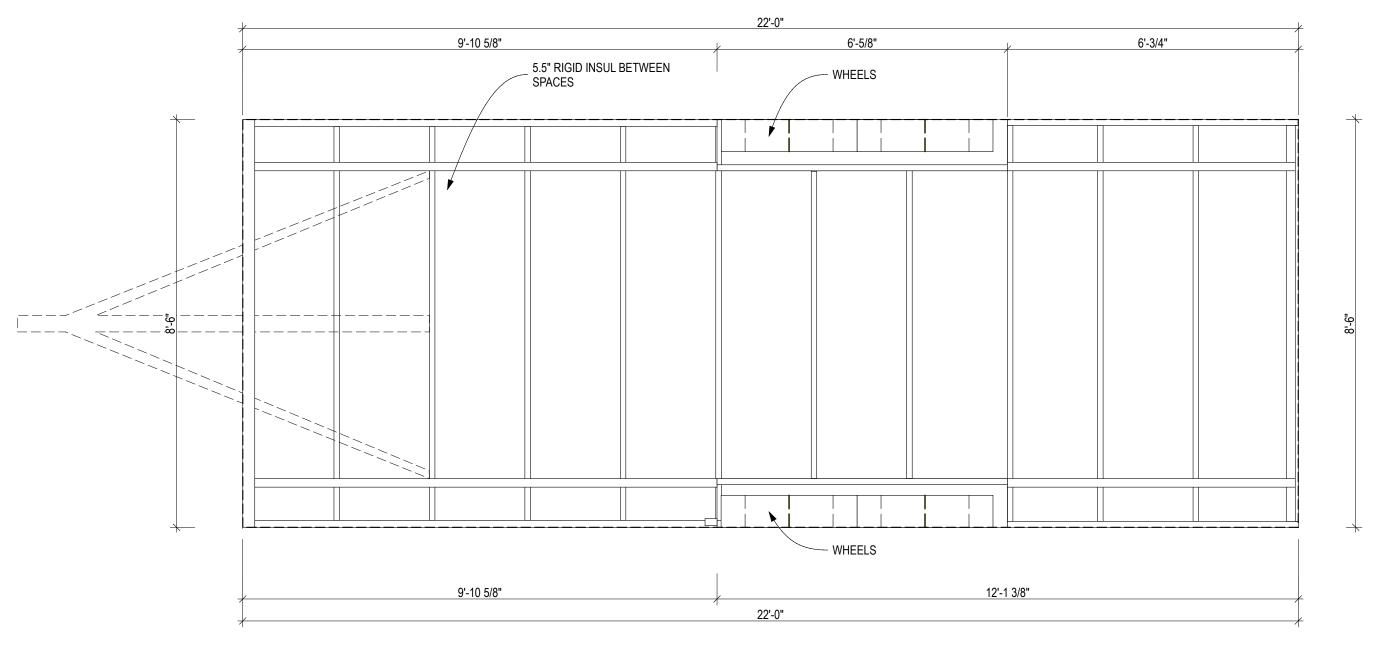

1 TRAILER FRAMING

SCALE: 1/2" = 1'-0"

RAII FR:

8'-6" x 22'-0" TRAILER - CONFIRM WITH SHOP DRAWINGS.

CONFIRM HEIGHT FROM GROUND TO TOP OF DECKING. ADJUST HEIGHT OF BUILDING TO MAX OF 13'-6" FROM ROAD.

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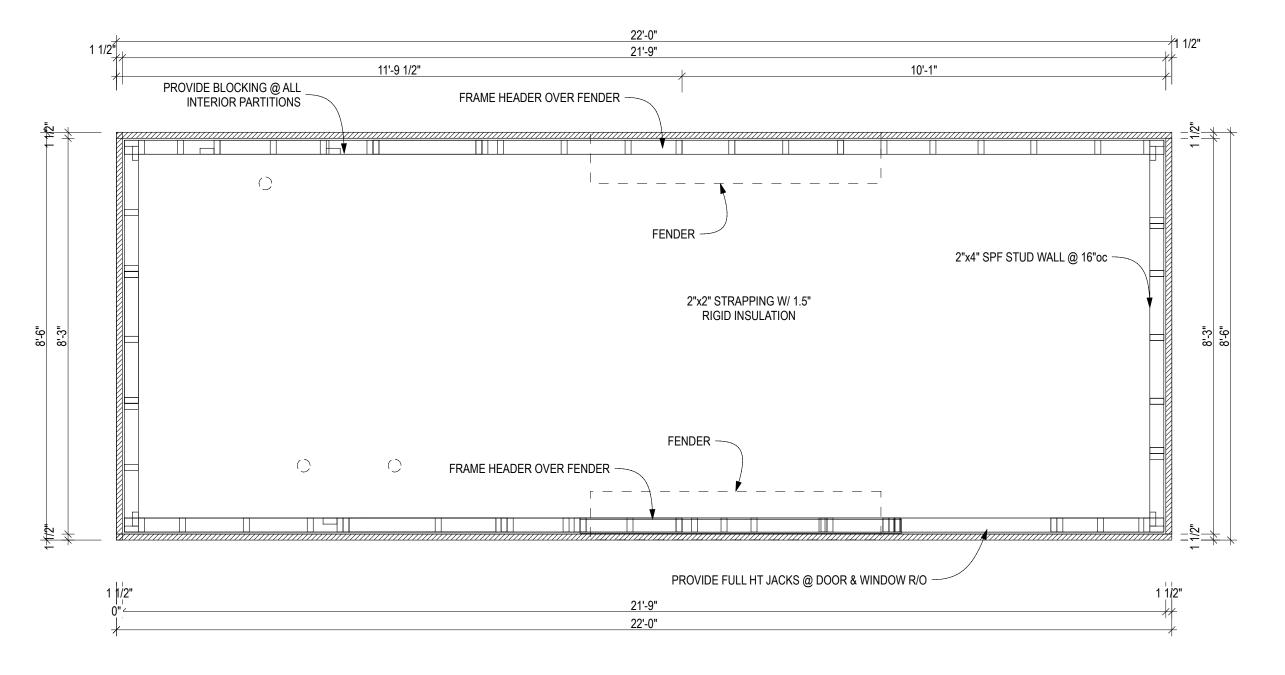
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TRAILER FRAMING

F2.0

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FRAMING NOTES:

WITH 5/8" THREADED BOLTS AT SIDES OF TRAILER & TO TRAILER DECKING USING A23 OR A35 FRAMING ANCHORS BRONZE OR COPPER FASTENERS PER IRC SEC R317. WITH SSD SCREWS. IF THE LATTER METHOD IS USED. METAL STRAPPING SHOULD ALSO BE INSTALLED TO TIE THE HOUSE STRUCTURE DIRECTLY TO THE TRAILER SUBSTRUCTURE.

2. SOLID BLOCKING REQ'D AT ALL BEARING POINTS OF FLOOR, CEILING & ROOF SYSTEMS PER IRC SEC'S R502 & R802 & IBC SEC'S 2308.8.2 & 2308.10.6.

(TYP, P.T. OR CEDAR)

4. FOR ALL PRESSURE PRESERVATIVE & FIRE-RETARDANT 1. HOUSE TO BE ANCHORED TO TRAILER SUBSTRUCTURE TREATED WOOD USE TREATMENT RATED CONNECTORS & HOT- DIPPED GALVANIZED, STAINLESS STEEL, SILICON

> 5. REFER TO MANUFACTURER'S INSTALLATION INSTRUCTIONS FOR FASTENERS & CONNECTORS.

6. LATERAL LOADS ON WALLS: EXTERIOR WALLS MUST HAVE ONE SECTION W/ A MIN 1/2" 4X8 SHEET OF UNBROKEN PLYWOOD, W/8D NAILS SPACED 3'c @ WDGES, 12"oc IN THE FIELD. 2-HUD2'S @ EACH 8' SIDE OF TINY HOUSE CONNECTED TO TRAILER FRAMING. USE SHEAR WALL 3. LUMBER SHALL BE PROTECTED AGAINST ROT & DECAY. RATED ADHESIVE AT ALL CONNECTIONS.

ASSEMBLIES:

FLOOR SYSTEM:

5/8" PLYWOOD T&G 1 1/2" RIGID INSUL 5 1/2" RIGID INSUL IN BETWEEN JOIST SPACES 1/2" PT PLYWOOD TO U/S TRAILER

LOFT FLOOR:

2"x4" T&G PINE DECKING 2x4 SPF #2 JOISTS @ 10"oc

EXTERIOR WALLS:

STANDING SEAM METAL SIDING 1.5" RIGID INSULATION **HOUSEWRAP** 7/16" OSB SHEATHING 2x4 SPF#2 STUDS @ 16"oc R12 BATT INSUL 6mil POLY AVB 3/8" PINE OR EQUIV. G1S PLYWOOD

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NUTANA COLLEGIATE TINY HOUSE


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FLOOR FRAMING





ASSEMBLIES:

ROOF:

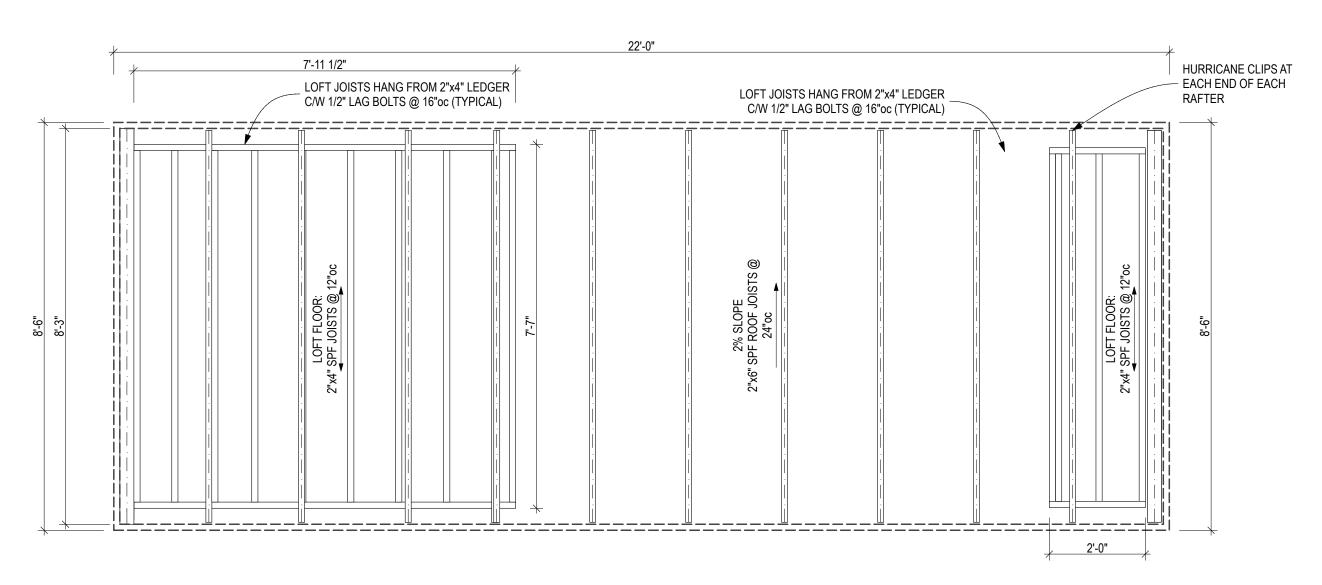STANDING SEAM METAL ROOF PEEL & STICK MEMBRANE 1/2" PLYWD GLUED & SCREWED 5.5" RIGID INSULATION 2"x6" SPF CEILING JOISTS @ 24"oc 3/4" PINE OR EQUIV G1S PLYWOOD

SKYLIGHT:

21"x27" VELUX VENTING DECK-MOUNT SKYLIGHT WITH TEMPERED LOW-E3 GLASS

FRAMING NOTES:

- 1. STRONG-TIE HI HURRICANE CLIPS @ EACH FULL BEARING RAFTER.
- 2. MIN 1/2" ROOF SHEATHING.
- 3. ROOF TOTAL WIDTH NEEDS TO BE 102" OR LESS @ FASCIA TO BE ROAD LEGAL.
- 4. STRONG-TIE RR CONNECTORS @ EACH FULL BEARING RAFTER OR COLLAR TIES SPACED NOT LESS THEN 48"oc.

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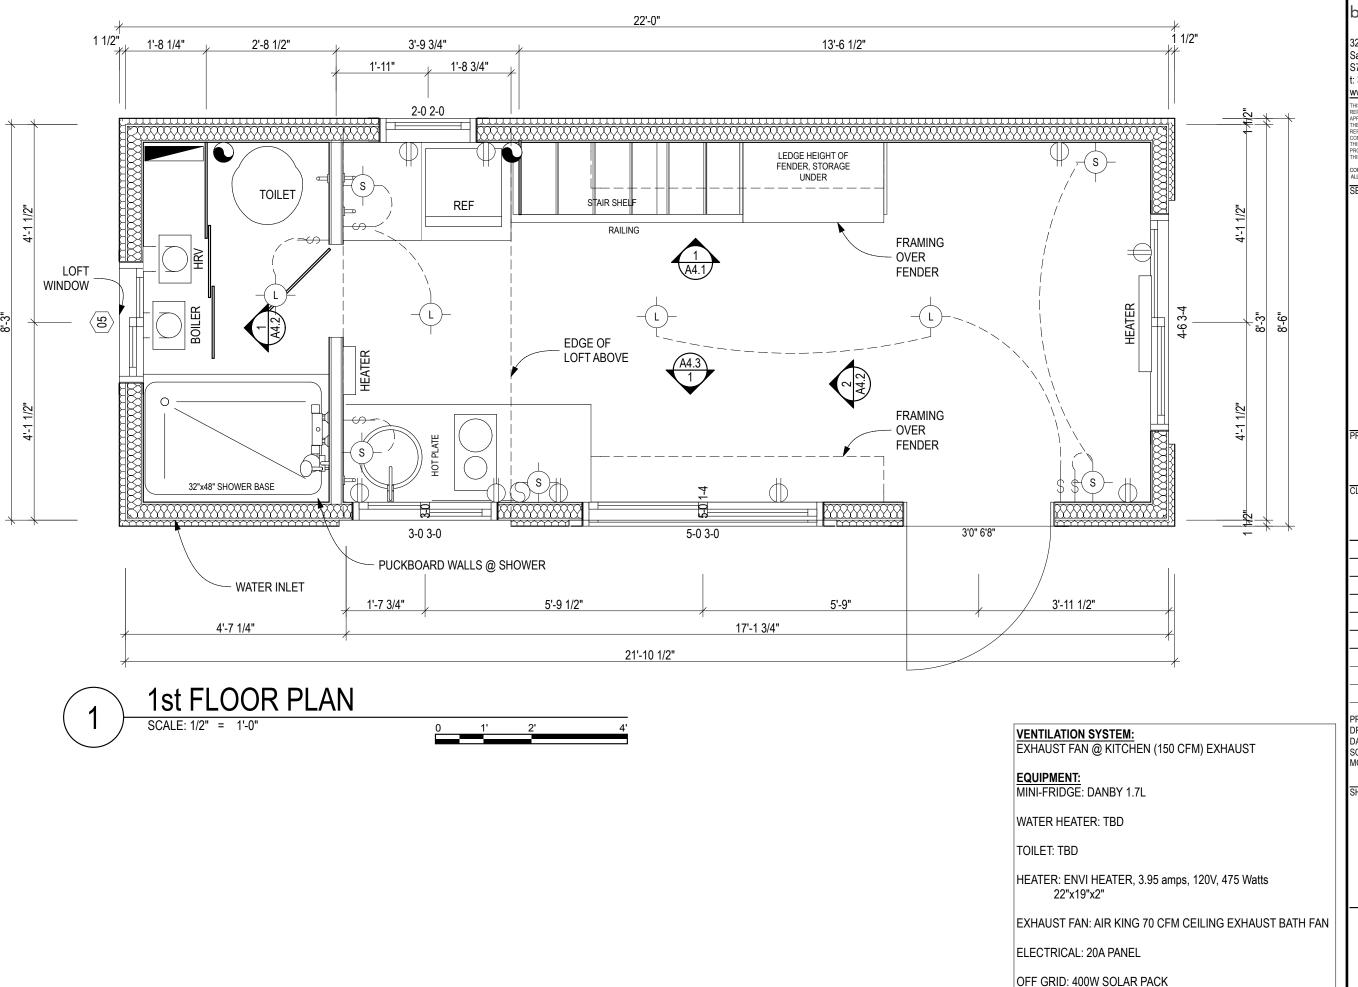
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SHEET TITLE

LOFT/ROOF FRAMING

F2.2



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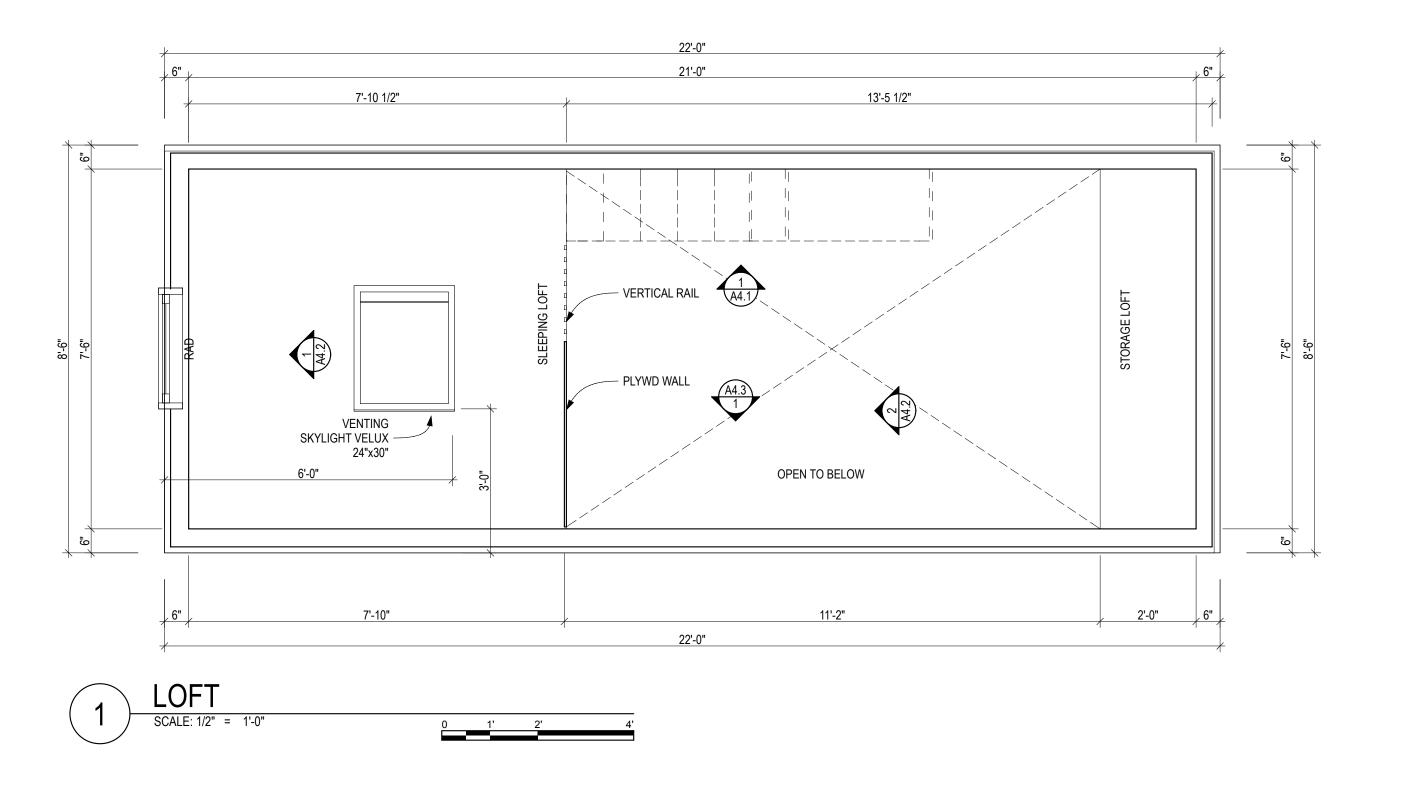
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SHEET TITLE

FLOOR PLAN

A2.1



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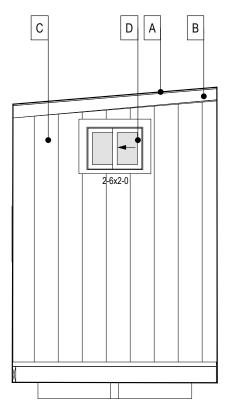
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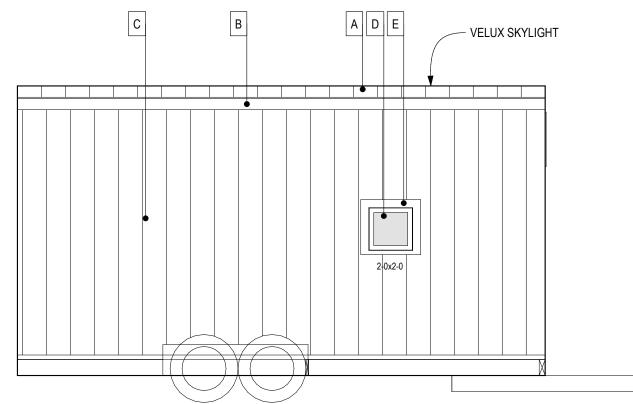
LOFT PLAN

A2.2




WEST ELEVATION

SCALE: 1/4" = 1'-0"




2 NORTH ELEVATION
SCALE: 1/4" = 1'-0"

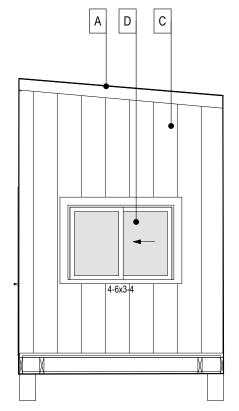

3 EAST ELEVATION

SCALE: 1/4" = 1'-0"

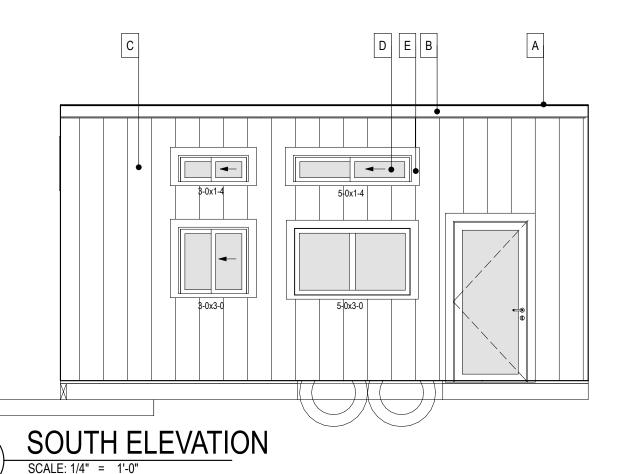

MATERIALS LEGEND:

- STANDING SEAM ROOF
- B CEDAR FASCIA STAINED
- C STANDING SEAM METAL SIDING
- D PVC WINDOWS WHITE
- E 4" STAINED CEDAR WINDOW TRIM

METAL SIDING NOTES:

EAVE AND GABLE TRIM TO BE 4" MAX.
ENSURE FRAMING MEMBERS BEHIND
STANDING SEAM CONNECTIONS.

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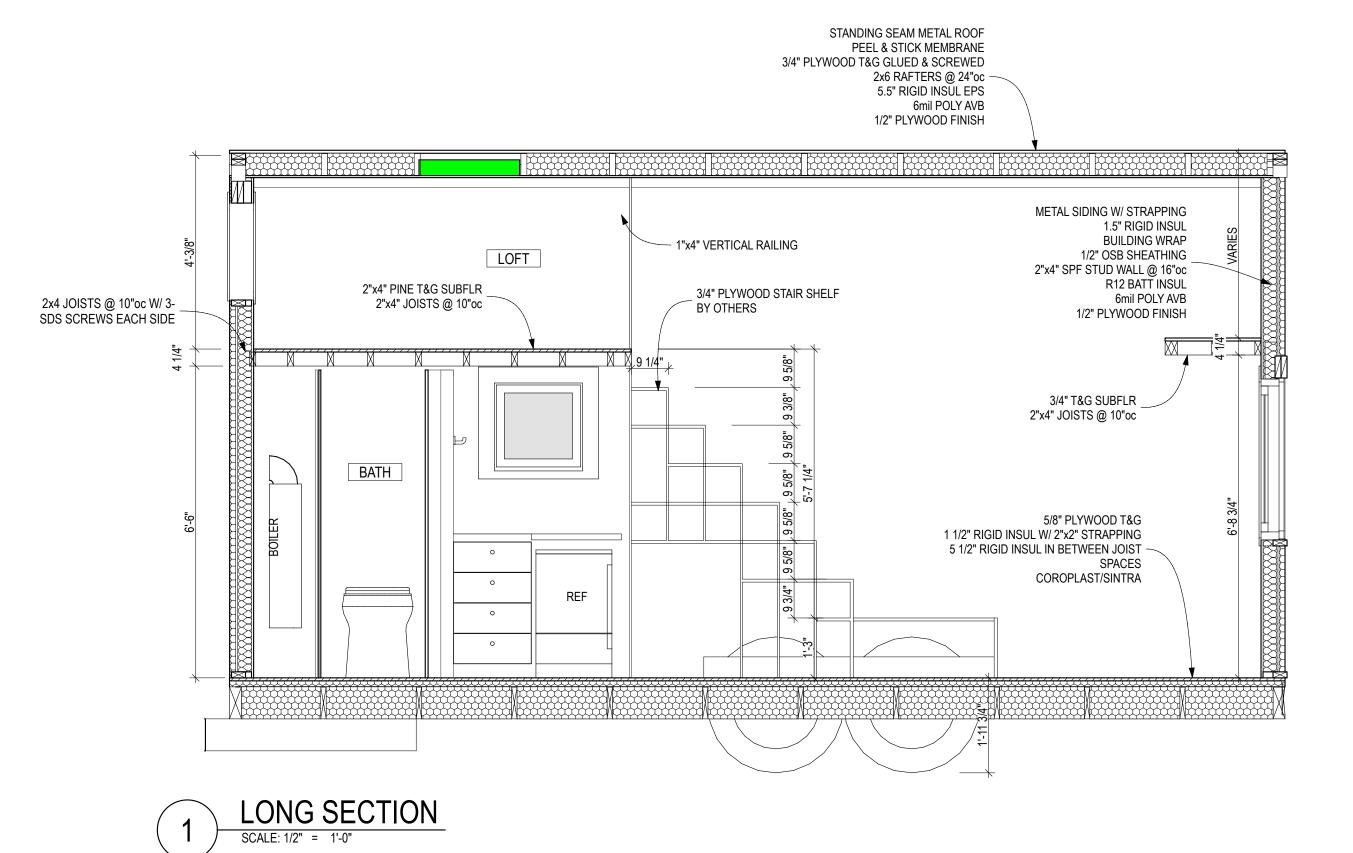
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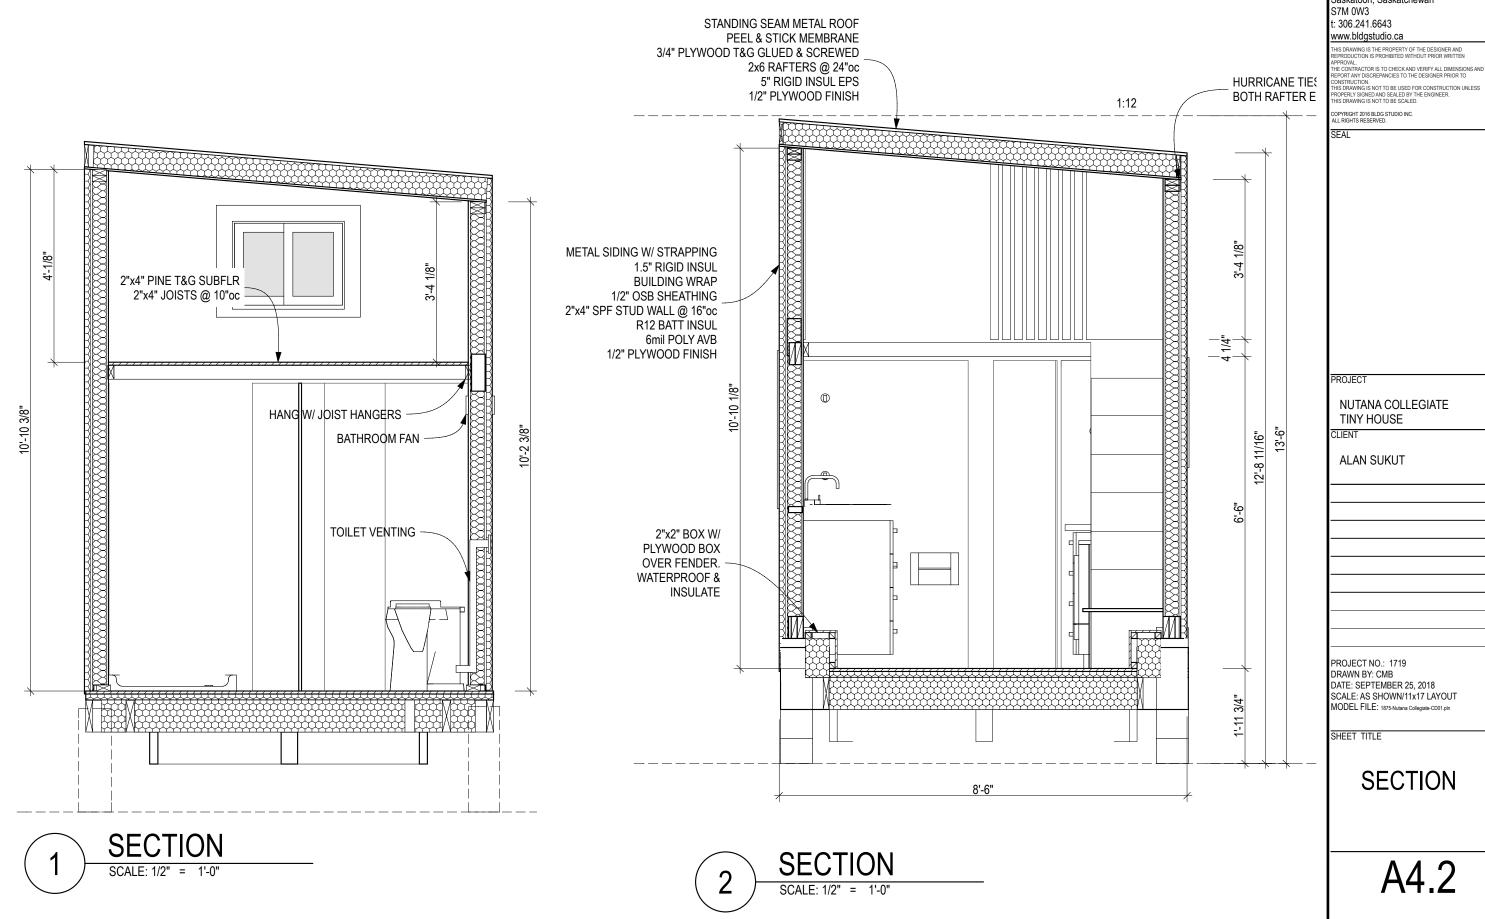
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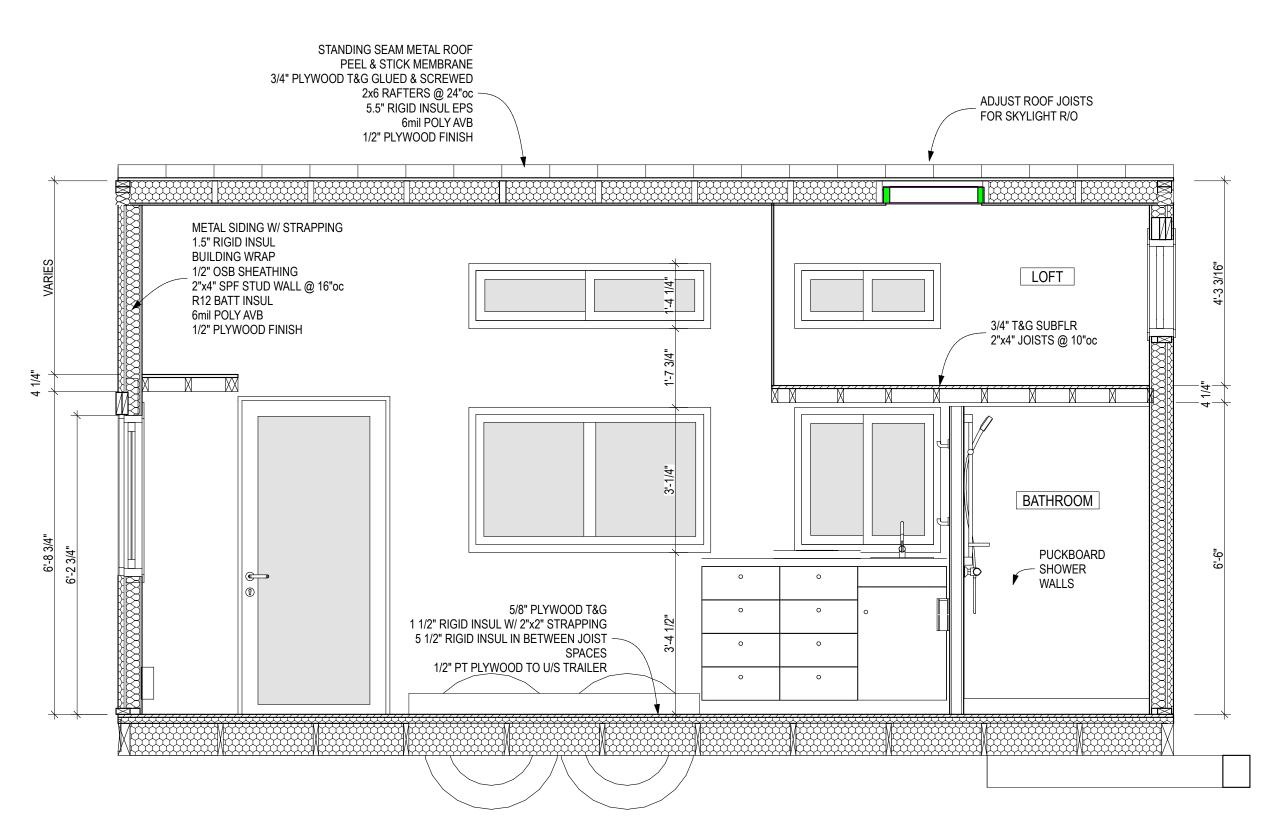
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SECTION

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